
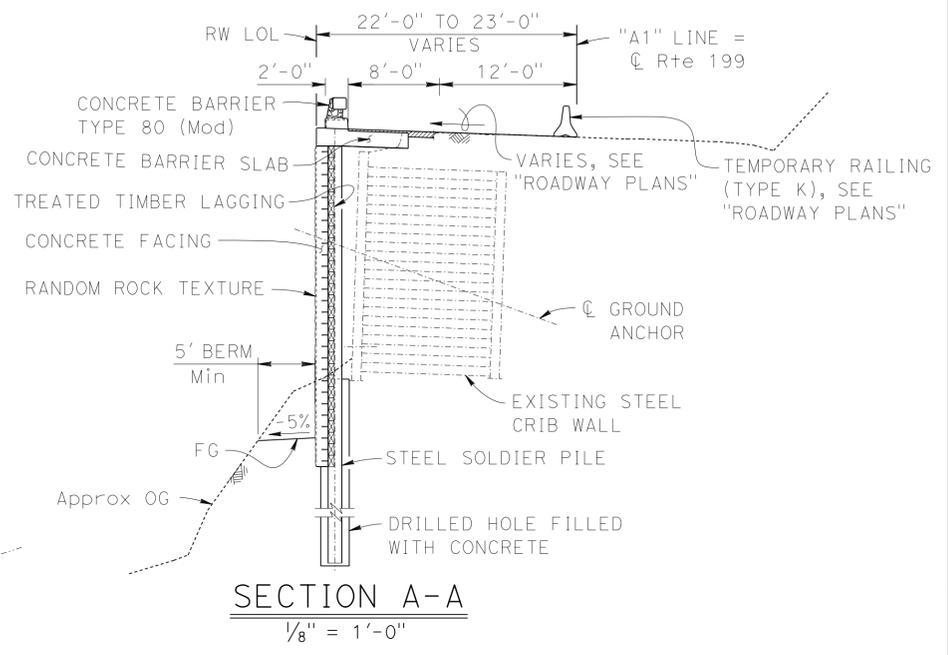


DIST	COUNTY	ROUTE	POST MILES TOTAL PROJECT	SHEET No.	TOTAL SHEETS
01	DN	199	24.7	36	51

Kevin J. Harper 3/25/15
 REGISTERED CIVIL ENGINEER DATE
 June 15, 2015
 PLANS APPROVAL DATE

The State of California or its officers or agents shall not be responsible for the accuracy or completeness of scanned copies of this plan sheet.

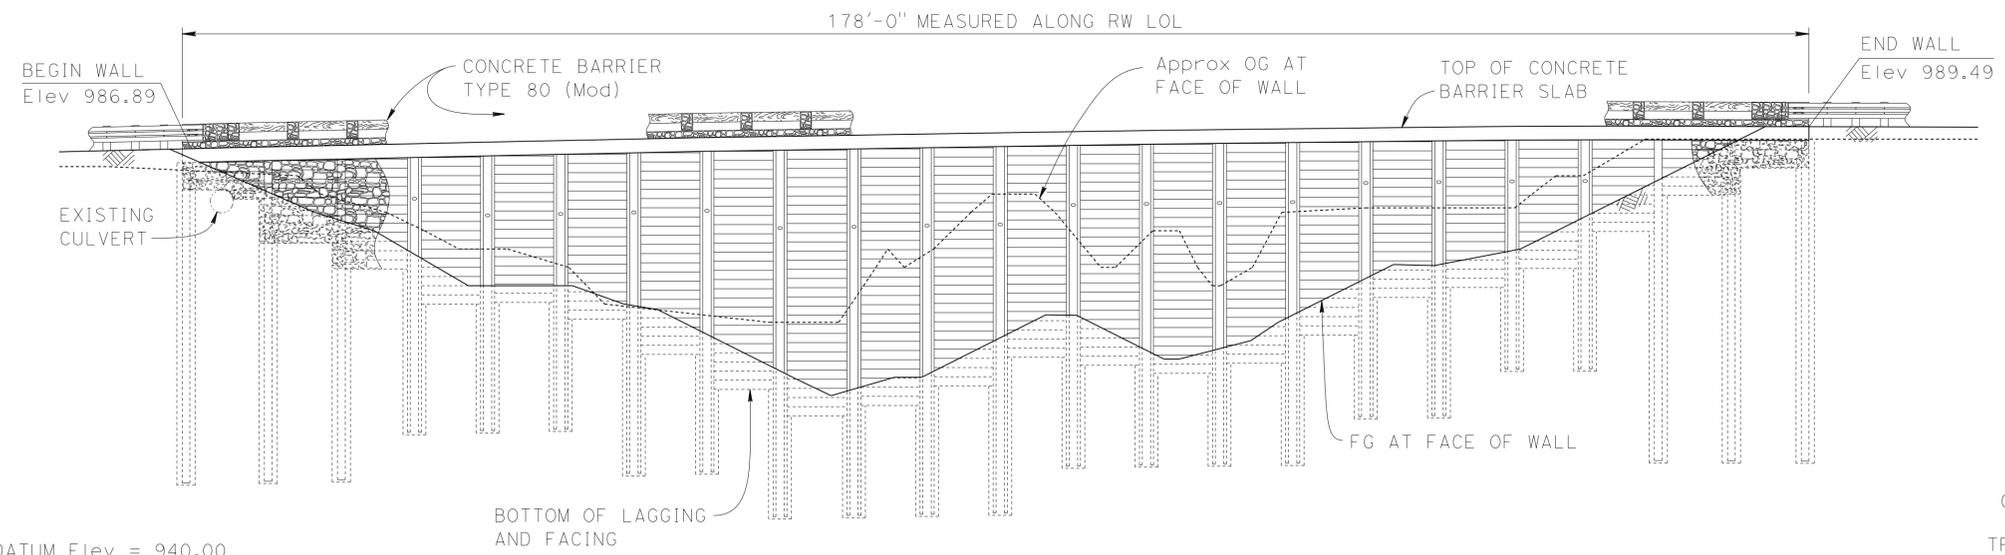

INDEX TO PLANS


SHEET NO.	TITLE
1.	GENERAL PLAN
2.	STRUCTURE PLAN NO. 1
3.	STRUCTURE PLAN NO. 2
4.	FOUNDATION PLAN
5.	TYPICAL SECTION
6.	WALL DETAILS No. 1
7.	WALL DETAILS No. 2
8.	GROUND ANCHOR DETAILS
9.	EXCAVATION AND BACKFILL LIMITS
10.	CONCRETE BARRIER TYPE 80 (Mod)
11.	FUTURE BICYCLE RAILING DETAILS
12.	LOG OF TEST BORINGS 1 OF 5
13.	LOG OF TEST BORINGS 2 OF 5
14.	LOG OF TEST BORINGS 3 OF 5
15.	LOG OF TEST BORINGS 4 OF 5
16.	LOG OF TEST BORINGS 5 OF 5

DEVELOPED MIRRORED ELEVATION

1" = 10'

STANDARD PLANS DATED 2010

A10A	ABBREVIATIONS (SHEET 1 OF 2)
RSP A10B	ABBREVIATIONS (SHEET 2 OF 2)
A10C	LINES AND SYMBOLS (SHEET 1 OF 3)
A10D	LINES AND SYMBOLS (SHEET 2 OF 3)
A10E	LINES AND SYMBOLS (SHEET 3 OF 3)
A10F	LEGEND - SOIL (SHEET 1 OF 2)
A10G	LEGEND - SOIL (SHEET 2 OF 2)
A10H	LEGEND - ROCK
RSP B11-60	CONCRETE BARRIER TYPE 80 (SHEET 1 OF 2)

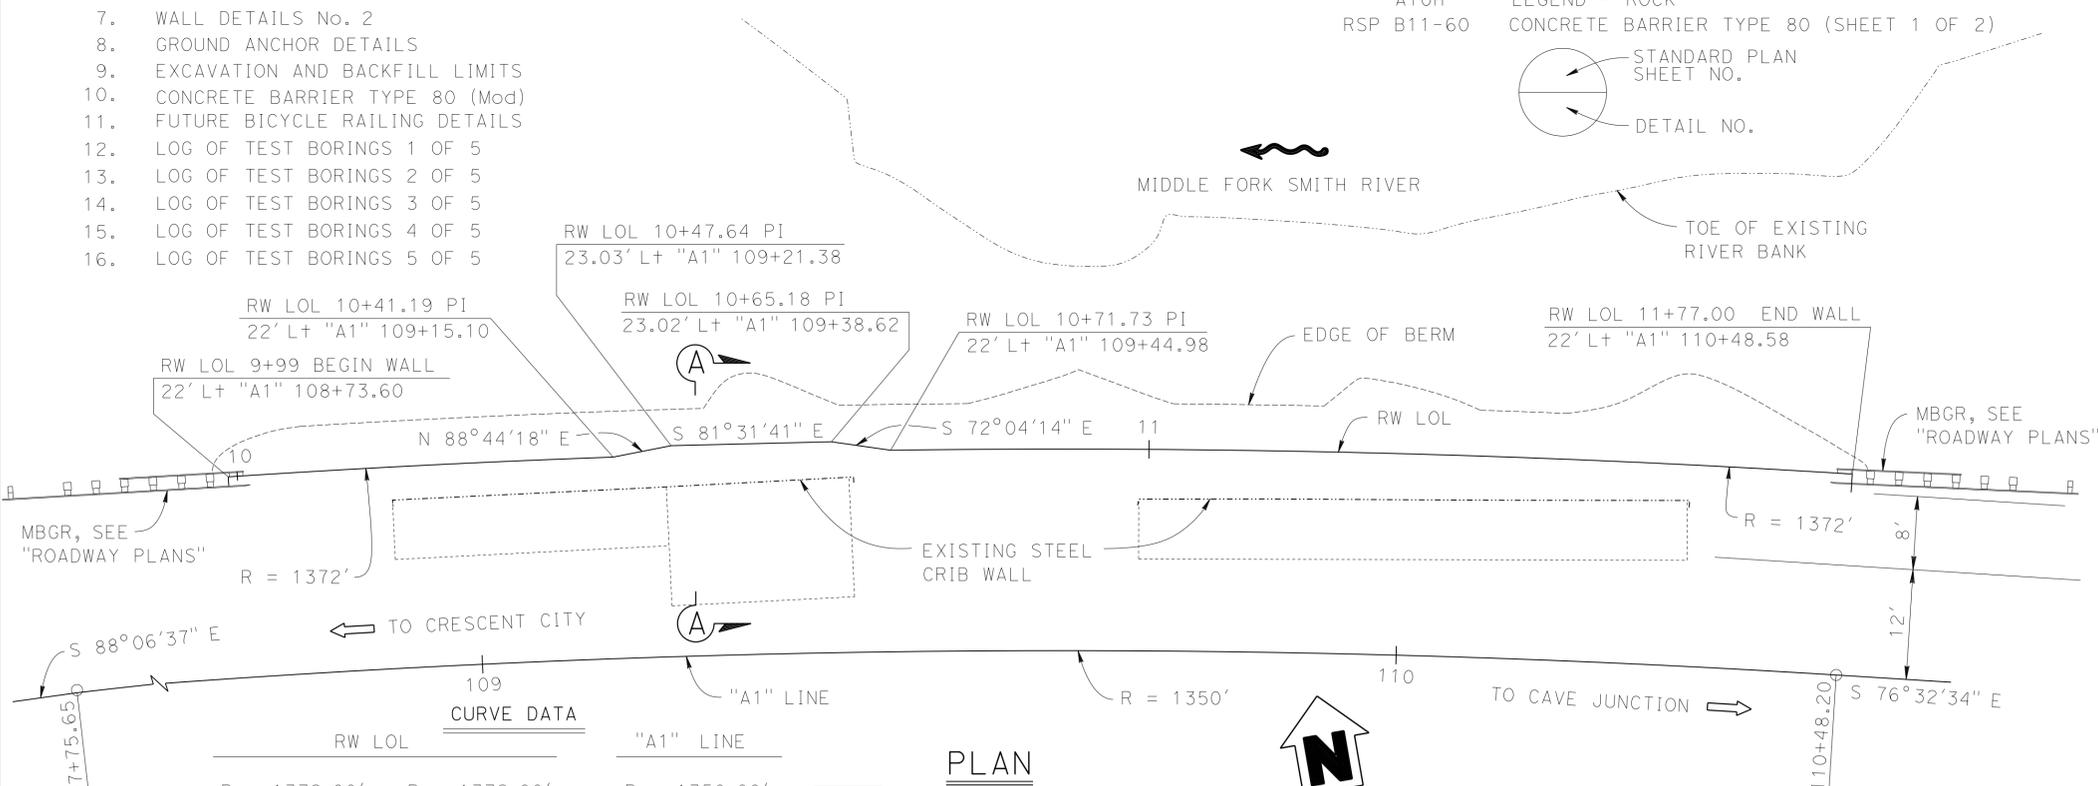

QUANTITIES

DESCRIPTION	QTY	UNIT
STRUCTURE EXCAVATION (SOLDIER PILE WALL)	150	CY
STRUCTURE BACKFILL (SOLDIER PILE WALL)	52	CY
CONCRETE BACKFILL (SOLDIER PILE WALL)	56	CY
LEAN CONCRETE BACKFILL	54	CY
GROUND ANCHOR (SUBHORIZONTAL)	17	EA
STEEL SOLDIER PILE (W 16 X 67)	210	LF
STEEL SOLDIER PILE (2-C 15 X 50)	570	LF
24" DRILLED HOLE	208	LF
30" DRILLED HOLE	394	LF
STRUCTURAL CONCRETE, RETAINING WALL	120	CY
STRUCTURAL CONCRETE, BARRIER SLAB	64	CY
RANDOM ROCK TEXTURE	3,130	SQFT
BAR REINFORCING STEEL (RETAINING WALL)	11,200	LB
TIMBER LAGGING	17	MFBM
CLEAN AND PAINT STEEL SOLDIER PILING	LUMP	SUM
PREPARE AND STAIN CONCRETE	3,130	SQFT
GEOCOMPOSITE DRAIN	534	SQFT
DRILL HOLE (CRIB WALL)	34	EA
CLASS 1 PERMEABLE MATERIAL, TYPE B	144	CY
CONCRETE BARRIER (TYPE 80 MODIFIED)	178	LF

PLAN
1" = 10'
REVISED PER ADDENDUM No.1 DATED OCTOBER 29, 2015
For "GENERAL NOTES", see "GROUND ANCHOR DETAILS" sheet. ----- Indicates Existing Structure

DESIGN	BY Kevin Harper	CHECKED Daniel Sessions	LOAD & RESISTANCE FACTOR DESIGN
DETAILS	BY Jie Tang	CHECKED Daniel Sessions	LAYOUT BY Kevin Harper
QUANTITIES	BY Eric Watson	CHECKED Bob Huddleston	SPECIFICATIONS BY Wanda Ward

STATE OF CALIFORNIA
 DEPARTMENT OF TRANSPORTATION
DIVISION OF ENGINEERING SERVICES
 STRUCTURE DESIGN
DESIGN BRANCH 1

BRIDGE NO. 01E0018
 POST MILE 24.67
MIDDLE FORK WALL
GENERAL PLAN